

ZONING BOARD OF APPEALS AGENDA Monday, March 11, 2024

Decatur City Hall City Commission Meeting Room 509 North McDonough Street 7:30 P.M.

I. Call to Order

II. Approval of Minutes

Approval of Minutes from the February 12, 2024, meeting.

III.Old Business

Derek Bigham, property owner, has applied for a variance from setback and height requirements for the property located at 102 5th Avenue, Decatur, GA 30030. *This project was deferred from the August 2023, November 2023, and January 2024 meetings.*

IV. New Business

None

V. Reports and Other Business

None

VI. Adjourn

VARIANCE APPLICATION

Planning & Zoning 2635 Talley Street Decatur, GA 30030 Phone 404-377-6198 Fax 404-378-5054



Attach a survey of the property drawn to scale and showing the following information. Please provide one full-size copy of all plans, as well as one copy of all plans in an 8½" x 11" format. It is helpful to show floor plans and elevations of proposed building improvements, as well as a letter of support from adjacent property owners. If the applicant is not the current property owner, provide a notarized authorization for this application from the current property owner. See the stream variance submittal checklist for additional requirements for stream variances.

- 1. all property lines with dimensions
- 2. location of buildings and other structures, creeks and easements referenced to property lines
- 3. north arrow, scale, lot and block numbers and land lot
- 4. topographic and drainage information if pertinent

Address of property 102 5th Avenue	Decatur, GA 30030
Name of applicant Derek Bigham	Phone 404-234-8520
Address PO Box 956012	City/state/ZIP Decatur, GA 30033
Email derek@invest2911.com	_
Name of property owner 2911 Investment Group LLC	Phone <u>404-234-8520</u>
Address PO Box 956012	City/state/ZIP Decatur, GA 30033
Current zoning of property <u>R-60</u>	_

Please answer all of the following questions on a separate sheet.

- 1. What is the variance requested? What code requirement do you wish to vary from?
- 2. What are the special conditions relating to the specific piece of property in question (narrowness, shallowness, shape, topography, or other extraordinary and exceptional situation)?
- 3. Explain how the application of the zoning ordinance to this specific piece of property results in peculiar, extraordinary and practical difficulties?
- 4. Are the circumstances or conditions applying to the building or land in question peculiar to the premises? Do they apply generally to other land or buildings in the vicinity?
- 5. Explain why the granting of this variance is necessary for the preservation and enjoyment of a property right and does not merely serve as a convenience to the applicant.
- 6. Did the condition for which the variance is sought result from an action by the applicant?
- 7. Explain how the variance will affect the supply of light and air to adjacent property, the traffic on public streets, the danger of fire, the public safety and established property values.
- 8. Explain how the granting of the variance will be in harmony with the general purpose and intent of the Decatur land use plan.

9. Will the granting of the variance allow a structure or use in a district restricted against such structure or use?

I hereby certify that the above and attached statements and documents are true to the best of my knowledge and belief.

Applicant signature ____



This is a revised version of our previous narrative. Previous discussions in ZBA meetings focused on the site's flooding and water issues. In this submission, our proposal includes an elevated slab to raise the main floor level approximately 3-4 feet above grade in the rear, addressing the water accumulation issue. Additionally, we plan to implement a sub-grade drainage system to channel excess stormwater into the on-site manhole and the public stormwater system.

For this hearing, we are seeking setback variances on all four sides: approximately .6' on the right side, zero on the Oakview side, around 15.9 feet in the rear, and about 15.9 feet for the front setback.

Regarding the setback request, a concern raised in the previous meeting was the impact of our proposed building on sightlines and safety. Based on the attached drawings and site photos, our assessment indicates minimal impact on visibility and safety.


Since Oakview is a split road, it is a one-way street on each side of the traffic island. Our building placement will not significantly affect traffic in the north or south directions. The provided pictures show a clear path of at least 134 plus feet when traveling southbound; even with my truck parked on the existing sidewalk(see photos), there is a clear line of sight for incoming traffic. Notably, the existing trees on the traffic island pose more of a hazard than our proposed building.

We are also seeking a F.A.R variance, presenting three options. Two options would require an additional 727 SF of heated space, while the third option would need 587 SF of F.A.R variance. As stated above, the footprint does not affect visibility on the site, so adding additional square footage on the second story has no impact on any of the factors that were brought up in previous meetings.

While showing a parking pad/carport in the easement area, we ensure access to the onproperty manhole for maintenance. We are proposing two options for the water management. One where downspouts tie into the manhole that is on the property and piped directly into the stormwater system, this should significantly reduce the flooding in that area. The second option is to do a permeable driveway.

We understand that we could build up to 27 feet, but if that is not the case, we request a height variance.

Photos are in link below. https://app.companycam.com/galleries/qyP9X7jK

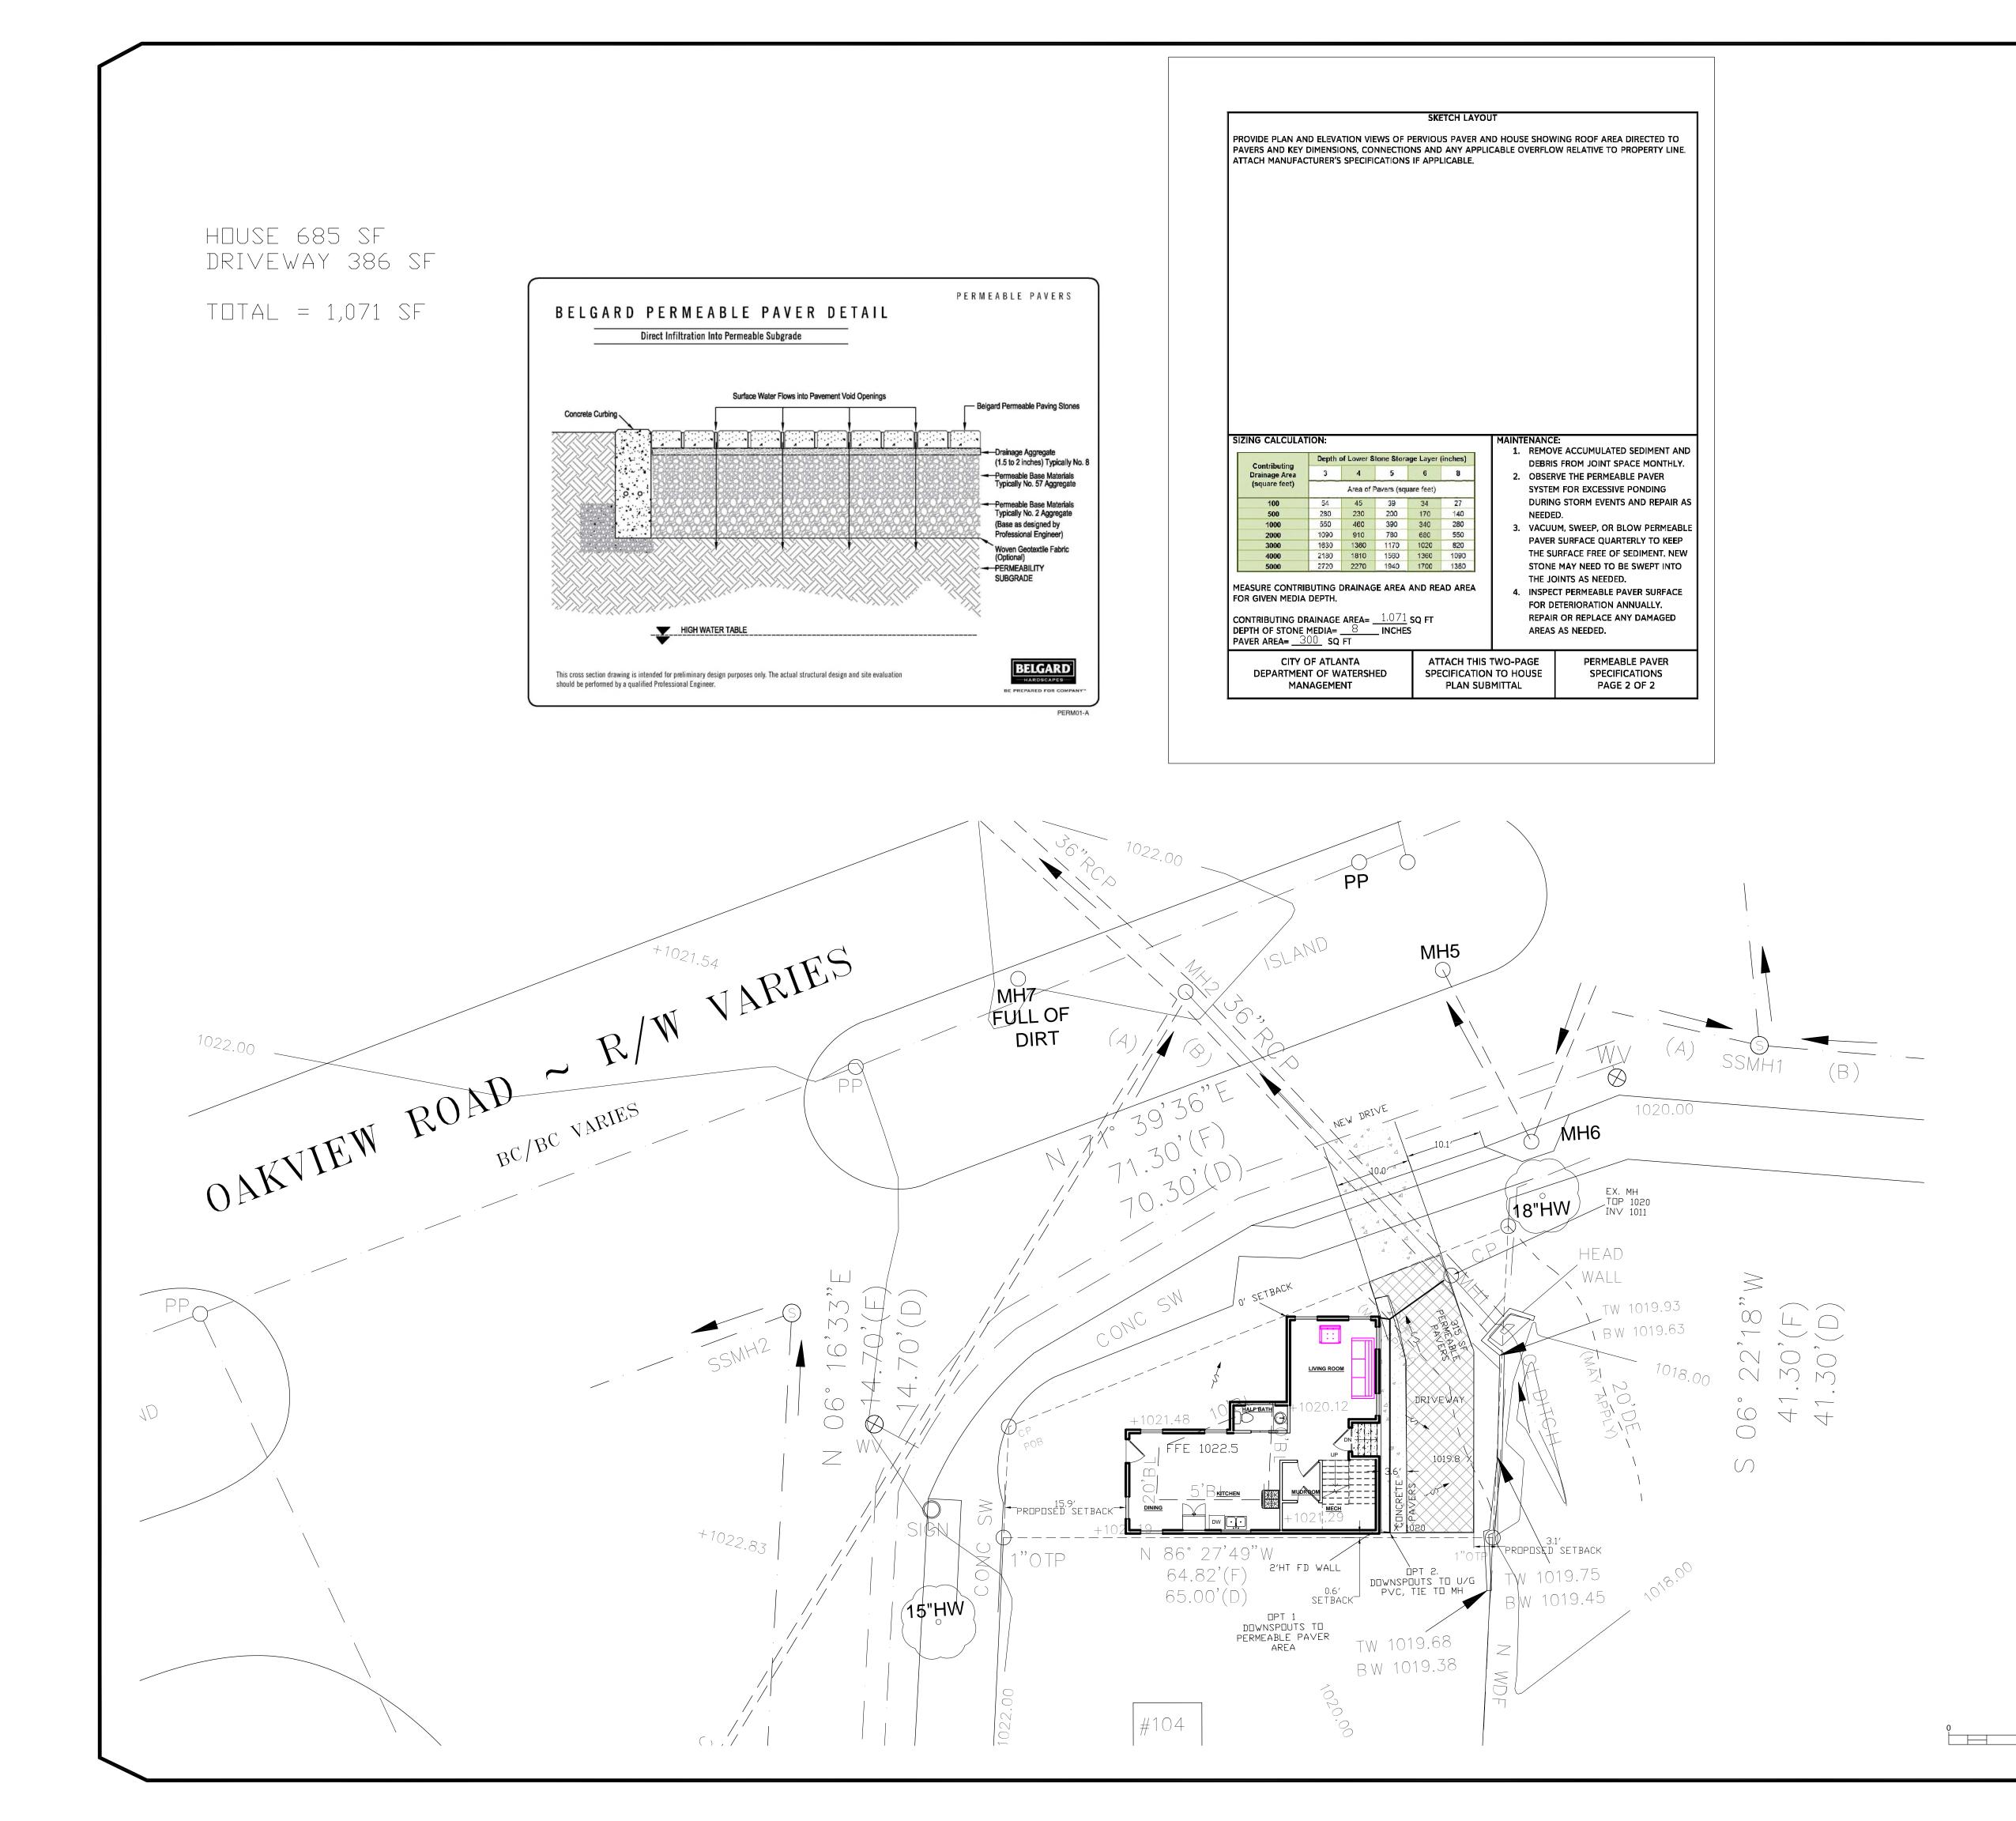

	HOW HOUSE OF Church & Conversion Rd Conversi	Dawson ENGINEERING CONSULTANTS, LLC 3487 CARLISLE COURT, SE CONYERS, GEORGIA 30013 PH: 678-485-9610 EMAIL: tonyd@dawsonec.com
	W G G G G G G G G G G G G G G G G G G G	DRAWN BY TLD CHECKED BY TLD APPRDVED:
		DATE ND. SCALE: 1" SCALE: 1" SCALE: 1"
		SITE PLAN FOR FOR TOZ 5TH AVE LOCATED AT LOCATED AT LOCATED AT LOCATED AT
10	20 Feet	

CODE COMPLIANCE

INTERNATIONAL BUILDING CODE, 2018 EDITION, WITH GEORGIA AMENDMENTS (2020)
INTERNATIONAL RESIDENTIAL CODE, 2018 EDITION, WITH GEORGIA AMENDMENTS
(2020)
INTERNATIONAL FIRE CODE, 2018 EDITION (CONTACT STATE FIRE MARSHAL BELOW)
INTERNATIONAL PLUMBING CODE, 2018 EDITION, WITH GEORGIA AMENDMENTS (2020)
INTERNATIONAL MECHANICAL CODE, 2018 EDITION, WITH GEORGIA AMENDMENTS
(2020)
INTERNATIONAL FUEL GAS CODE, 2018 EDITION, WITH GEORGIA AMENDMENTS (2020)
NATIONAL ELECTRICAL CODE, 2020 EDITION (NO GEORGIA AMENDMENTS)
INTERNATIONAL ENERGY CONSERVATION CODE, 2015 EDITION, WITH GEORGIA
SUPPLEMENTS AND AMENDMENTS (2020)
INTERNATIONAL SWIMMING POOL AND SPA CODE, 2018 EDITION, WITH GEORGIA
AMENDMENTS (2020)

CODE REQUIREMENTS

- ALL CONSTRUCTIONS TO BE IN ACCORDANCE WITH THE APPLICABLE
- CODES, REGULATIONS AND ORDINANCES OF THE LOCAL CODES. CONTRACTOR TO FIREPROOF AS REQUIRED BY THE LOCAL CODES CONTRACTOR TO BE RESPONSIBLE THAT ALL CONSTRUCTION AND
- MATERIAL SELECTION CONFORM WITH ALL CODES, REGULATIONS AND ORDINANCES OF FEDERAL, STATE, AND LOCAL CODES
- THE CONTRACTOR TO HAVE A LICENSED SURVEYOR TO LAYOUT THE EXISTING AND PROPOSED BUILDING AND SETBACK LINES BEFORE STARTING CONSTRUCTION AND DIGGING FOUNDATIONS.
- THE CONTRACTOR IS TO VERIFY THE STRUCTURE IS IN COMPLIANCE WITH THE ZONING AND SETBACKS
- THE CONTRACT OR PROVIDE ALL REQUIRED BUILDING PERMITS BEFORE STARTING ANY WORK. CONTRACTOR TO PROVIDE ALL
- CERTIFICATES OF OCCUPANCY PERMITS TO OWNER AT COMPLETION CONTRACTOR TO HIRE STRUCTURAL ENGINEER TO VERIFY ALL STRUCTURAL LOADS, BEAM SIZES AND BEAM LOCATIONS BEFORE THE
- START OF PROJECT CONTRACTOR TO HIRE A SOILS ENGINEER (OR STRUCTURAL ENGINEER) TO VERIFY EXIST. SOIL STRENGTHS AND NEW FOOTING
- SIZES REQUIRED
- ALL WORK IS TO COMPLY WITH THE LATEST ADOPTED VERSION OF THE UNIFORM BUILDING CODE AND ANY APPLICABLE STATE, COUNTY OR LOCAL REGULATIONS.
- THE CONTRACTOR IS RESPONSIBLE TO CHECK THE PLANS AND IS TO NOTIFY THE DESIGNER OF ANY ERRORS OR OMISSIONS PRIOR TO THE START OF CONSTRUCTION.
- WRITTEN DIMENSIONS HAVE PRECEDENCE OVER SCALED DIMENSIONS DO NOT SCALE THE DRAWINGS.

ROOF

FLOOR

STAIRS

DECKS

DESIGN LOADS: (LIVE)

25 PSF (LIVE LOAD) 40 PSF 100 PSF GARAGE FLOOR 50 PSF (2000" PT) 60 PSF

(IF YOUR LOCAL AREA REQUIRES DIFFERENT DESIGN LOADS CONSULT WITH A LOCAL STRUCTURAL ENGINEER TO DETERMINE THE APPROPRIATE REVISIONS.)

- 5. INSULATION:
- ROOF (VAULTED) R-30 R-28 ROOF (FLAT) WALLS (EXTERIOR) R-19 FLOOR OVER UNHEATED SPACE) R-25 BASEMENT WALLS (W/12° OF GRADE) R-21 SLAB ON GRADE FURNACE DUCTS (UNHEATED SPACE) R-8 BASEMENT WALLS (HEATED) R-15
- THE ABOVE VALUES ARE A MINIMUM AND MAY BE INCREASED IF DESIRED. VERIFY WITH CONTRACTOR.
- ALL EXPOSED INSULATION IS TO HAVE A FLAME SPREAD RATING OF
- LESS THAN 25 AND A SMOKE DENSITY RATING OF LESS THAN 450 PROVIDE INSULATION BAFFLES AT EAVE VENTS BETWEEN RAFTERS.
- ROOF VENTS TO TOTAL MORE THAN 1/300 OF THE ATTIC AREA BEING VENTILATED.

FRAMING NOTES

1. ALL EXTERIOR WALL OPENINGS AND BEARING WALL OPENING TO HAVE (2) 2X12 HEADERS UNLESS OTHERWISE NOTED

2. JOISTS THAT ARE ATTACHED TO FLUSH BEAMS ARE TO BE HUNG WITH SUMPSON " LUS210" OR EQUIVALENT.

3. PROVIDE DOUBLE OR TRIPLE JOISTS UNDER ALL PARALLEL PARTITIONS OVER PROVIDED FIRE BLOCKING. DRAFTSTOPS & FIRESTOPS AS PER ICC RESIDENTIAL CODE 2006.

4. HIP, VALLEY RAFTERS AND RIDGE BOARDS TO ALWAYS BE A BOARD SIZE 2" LARGER THAN RAFTERS.

5. PROVIDE COLLAR TIES @ THE UPPER THIRD(1/3) OF VERTICAL DISTANCE BETWEEN RIDGE BOARD AND JOISTS @ 4'-0 O.C.

6. PROVIDE "X" BRIDGING @ 8'-0" O.C MAXIMUM PER JOIST

7.PROVIDE SOLID BLOCKING AT MIDHEIGHT FOR ALL WALLS.

8.ALL LUMBER IN CONTACT WITH CONCRETE OR MASONRY SHALL BE PRESSURE-TREATED (P.T) 9. ANCHOR BOLTS SHALL BE 3/4"x10" @ 48" O.C. AND BE WITHIN 12" FROM THE END OF SILLS AND CORNERS.PROVIDE MINIMUM OF TWO (2) BOLTS PER SILL EMBEDDED 7" INTO CONCRETE OR

10. PROVIDE CONTINUOUS PERFORATED EAVE VENTS FOR ATTIC VENTILATION

11. PROVIDE CONTINUOUS PERFORATED EAVE VENTS FOR ATTIC VENTILATION

12. LUMBER SPECIES:

MASONRY.

A. POSTS, BEAMS, HEADERS, JOISTS AND RAFTERS - NO. 1 OR NO. 2 SOUTHERN YELLOW PINE. B.BLOCKING, BRIDGING, ETC. - NO. 1 OR NO.2 SOUTHERN YELLOW PINE

C.SILLS & PLATES - PRESSURE TREATED (P.T)

D. STUDS - NO. 1 OR NO.2 GRADE PRECUT STUDS (SOUTHERN YELLOW PINE OR DOUGLAS FIR).

E. POST & BEAM DECKING - UTILITY GRADE D.F.

F. PLYWOOD SHEATHING - CDX PLYWOOD (SEE PLANS FOR SIZE).

13. ALL BASEMENT LEVEL STUDS SHALL BE 9'-0' IN HEIGHT FRAMED WITH PRESSURE - TREATED SINGLE BOTTOM PLATE AND DOUBLE TOP PLATE (2 X MATERIAL).

14. ALL MAIN LEVEL STUDS SHALL BE 10'-0" IN HEIGHT FRAMED WITH SINGLE BOTTOM-PLATE AND DOUBLE TOP PLATE (2 X MATERIAL), ALL SECOND FLOOR STUDS SHALL BE 10'-0" IN HEIGHT FRAMED WITH SINGLE BOTTOM-PLATE AND DOUBLE TOP PLATE (2 X MATERIAL)

15.ALL EXTERIOR WALL SHALL BE FRAMED WITH 2X4 STUDS @ 16" O.C.MAX. U.N.O

16. ALL INTERIOR WALLS SHALL BE FRAMED USING 2X4 STUDS @ 16" O.c UNLESS OTHERWISE NOTED.ANY NOTED INTERIOR WALLS FRAMED WITH 2X6 STUDS SHALL ALSO BE @ 16" O.C



<u>3D View 1</u>

- ALL EXTERIOR WALL OPENINGS & BEARING WALL OPENINGS TO HAVE 4 X 12 HEADERS UNLESS OTHERWISE INDICATED. JOISTS THAT ARE ATTACHED TO FLUSH BEAMS ARE TO BE HUNG WITH "SIMPSON" U-210
- OR EQUIV.

- LUMBER SPECIES:
- B. SILL8, PLATES, BLOCKING, BRIDGING ETC. C. STUDS D. POST 4 BEAM DECKING
- E. PLYWOOD SHEATHING F. GLU-LAM BEAMS

NAILING SCHEDULE:

JOIST TO SILL OR GIRDER BRIDGING TO JOIST 2" SUBFLOOR TO TO GIRDER SOLE PL. TO JOIST TOP PL. TO STUDS STUD TO SOLE PL

DOUBLE STUDS DOUBLE TOP PL CONTINUOUS HEADER (2 PC. CLG. JST. TO PL. CLG. JST. LAP OVER PL CLG. JST. TO RAFTER RAFTER TO TOP PL BUILT-UP CORNER STUDS PLYWOOD SUBFLOOR

PLY WALL 4 ROOF SHEATHING

TOP PL. AT INTERSECTIONS MULTIPLE JOISTS (UP TO 3) MULTIPLE JOISTS (OVER 3)

1 X 6 SPACED SHEATHING

MANUFACTURED TRUSS JOISTS MAY BE SUBSTITUTED FOR 2 X JOISTS WHERE APPLICABLE.

102 5TH AVE DECATUR GA 30030


- PROVIDE DOUBLE JSTS. UNDER ALL WALLS ABOVE RUNNING PARALLEL TO JOISTS.
- PROVIDE FIREBLOCKING, DRAFTSTOPS & FIRESTOPS AS PER THE U.B.C. SEC. 2516F.


A. POSTS, BEAMS, HEADERS, JOISTS AND RAFTERS


NO. 2 DOUGLAS FIR NO. 3 DOUGLAS FIR STUD GRADE DF. UTILITY GRADE DF 1/2" CDX PLY, 32/16 Fb-2400, DRY ADH.


	3-8d	TOE NAIL
	2-8d	TOE NAIL
	2-16d	BLIND & FACE
	16d @ 16''	FACE NAIL
		END NAIL
	4-8d	TOE NAIL OR
	2-16ed	END NAIL
	16d @ 16''	FACE NAIL
	16d @ 16"	FACE NAIL
)	16d @ 16"	
,		TOE NAIL
	3-l6d	FACE NAIL
	3-16d	FACE NAIL
	3-8d	TOE NAIL
	16d @ 24"	FACE NAIL
	8d @ 6"	EDGE NAIL
	8d @ 10"	INTERIOR
G	8d © 6"	EDGE NAIL
	8d © 12"	INTERIOR
		FACE NAIL
	16d @ 15"	STAGGER NAIL
	1/2" DIA. BOLTS	WAUASHERS
	EA. SIDE @ 24"	
	2-8d	FACE NAIL


- EACH BEDROOM TO HAVE A MINIMUM WINDOW OPENING 5.7 SQ FT. WITH A MINIMUM WIDTH OF 20 IN, MINIMUM HEIGHT OF 22 IN. AND WITH A SILL LESS THAN 44 IN. ABOVE FIN. FLR
- ALL WINDOWS WITHIN 18 IN. OF THE FLOOR, AND WITHIN 24 IN. OF ANY 2 DOOR ARE TO HAVE TEMPERED GLAZING.
- SKYLITES ARE TO BE GLAZED WITH TEMPERED GLASS ON OUTSIDE AND LAMINATED GLASS ON INSIDE (UNLESS PLEXIGLAS). GLASS TO HAVE MAXIMUM CLEAR SPAN OF 25 IN. AND FRAME IS TO BE ATTATCHED TO A 2X CURB WITH A MINIMUM OF 4 IN. ABOVE ROOF PLANE.
- ALL TUB AND SHOWER ENCLOSURES ARE TO BE GLAZED WITH SAFETY 4 GLASS.
- ALL EXTERIOR WINDOWS ARE TO BE DOUBLE GLAZED LOWE AND ALL EXTERIOR DOORS ARE TO BE SOLID CORE WITH WEATHERSTRIPPING PROVIDE 1/2 IN. DEADBOLT LOCKS ON ALL EXTERIOR DOORS, AND LOCKING DEVICES ON ALL DOORS AND WINDOWS WITHIN ID FT. (VERTICAL) OF GRADE. PROVIDE PEEP-HOLE 54 - 66 IN. ABOVE FIN. FLOOR ON EXTERIOR ENTRY DOORS.
- CONNECT ALL SMOKE DETECTORS (SEE PLAN FOR LOCATION) TO HOUSE ELECTRICAL SYSTEM AND INTERCONNECT EACH ONE, SO THAT, WHEN ANY ONE IS TRIPPED, THEY WILL ALL SOUND. RETROFIT ALL BEDROOMS AND CORRIDORS THAT GIVE ACCESS TO BEDROOMS TO THE SMOKE ALARM SYSTEM.
- PROVIDE COMBUSTION AIR VENTS (W/ SCREEN AND BACK DAMPER) FOR FIREPLACES, WOOD STOVES AND ANY APPLIANCES WITH AN OPEN FLAME.
- BATHROOMS AND UTILITY ROOMS ARE TO BE VENTED TO THE OUTSIDE WITH A FAN CAPABLE OF PRODUCING A MINIMUM OF 4 AIR EXCHANGES PER HOUR RANGE HOODS ARE ALSO TO BE VENTED TO THE OUTSIDE.
- ELECTRICAL RECEPTACLES IN BATHROOMS, KITCHENS OF AND GARAGES SHALL BE G.F.I. OR G.F.I.C. PER NATIONAL ELECTRICAL CODE REQUIREMENTS.
- TOP OF GUARDRAILS SHALL NOT BE LESS THAN 36" IN HEIGHT. PICKETS 10. SHALL BE SPACED SO THAT A 4" @ SPHERE CANNOT PASS BETWEEN.

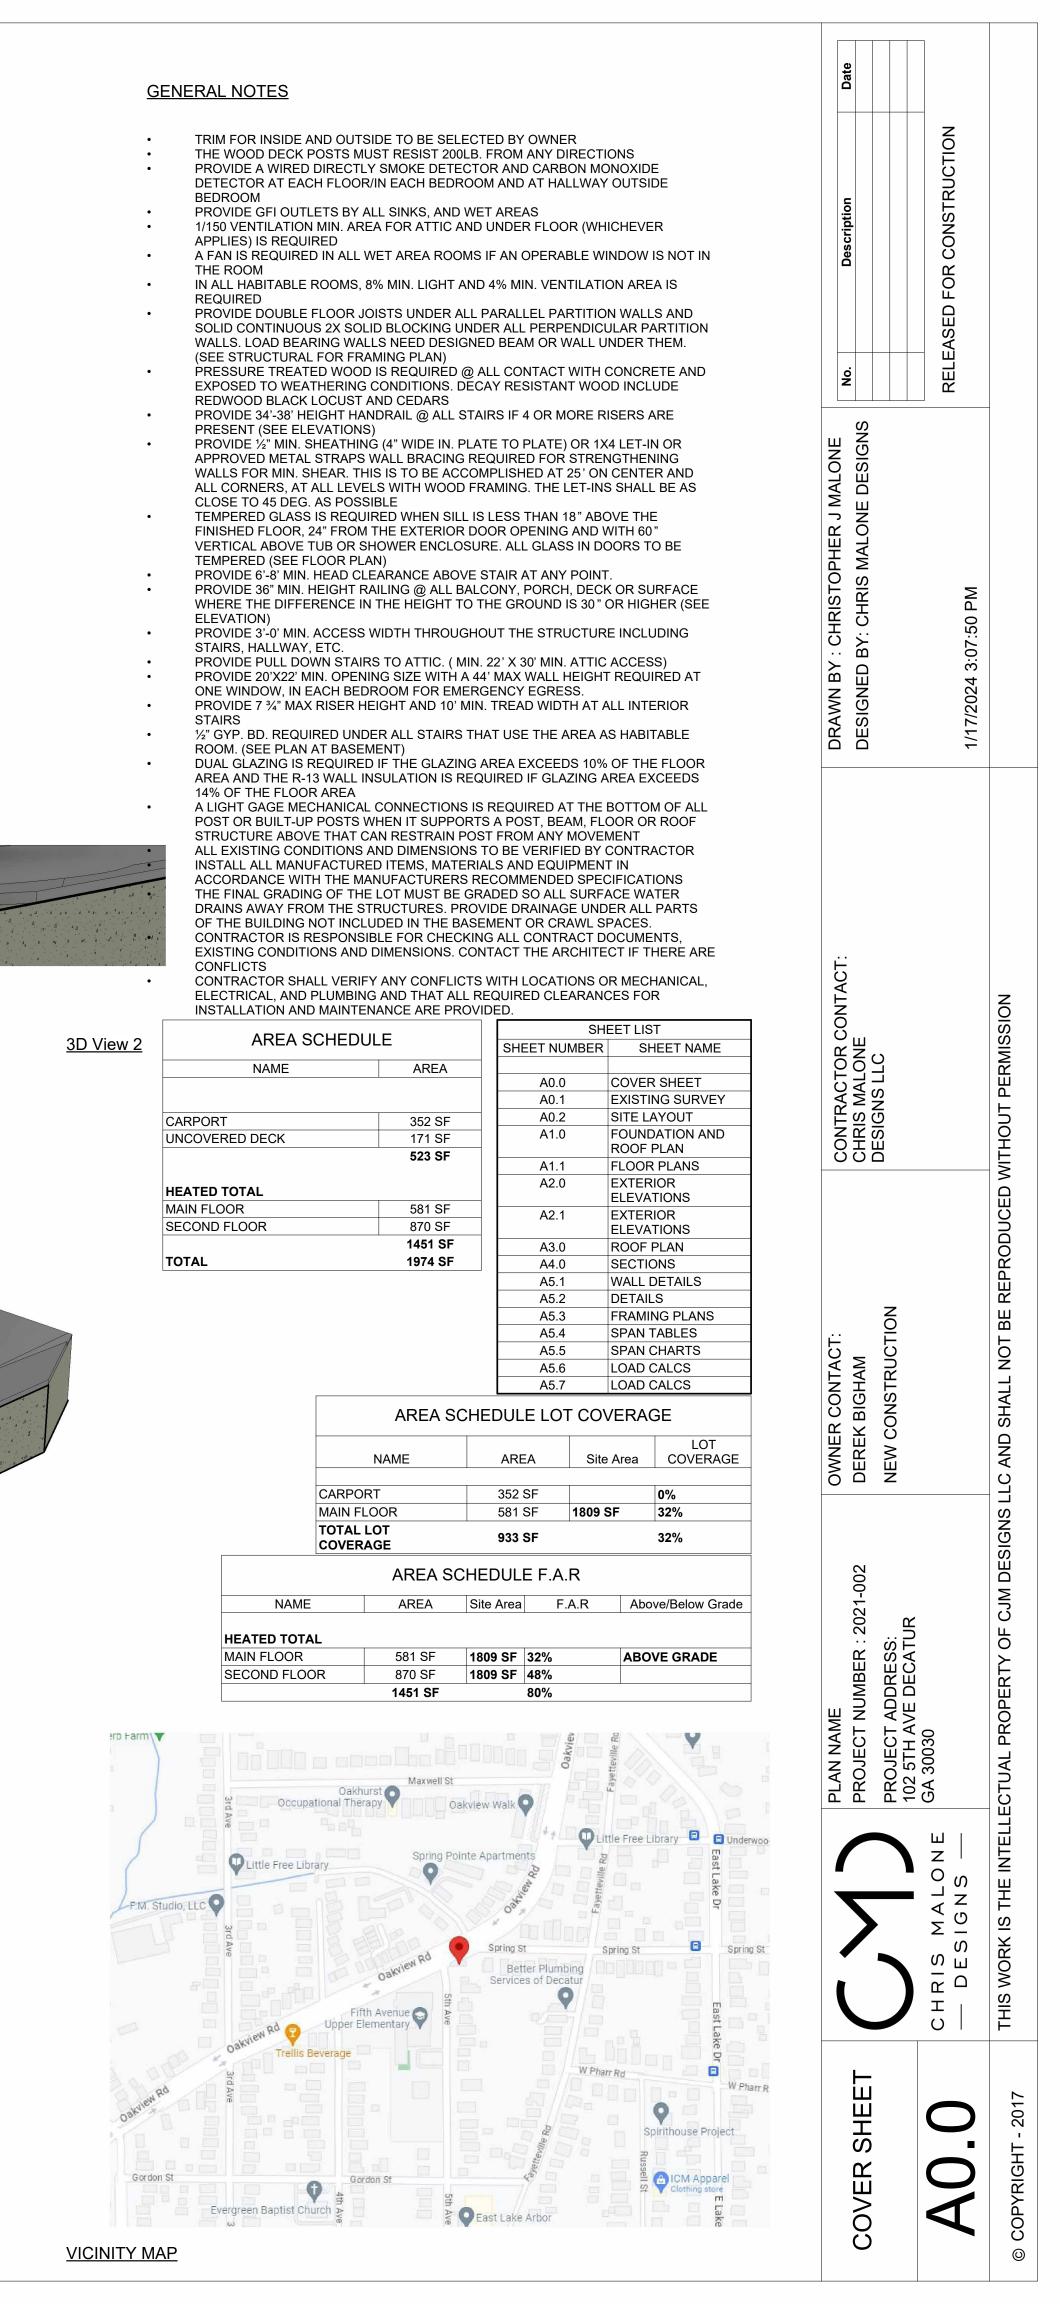

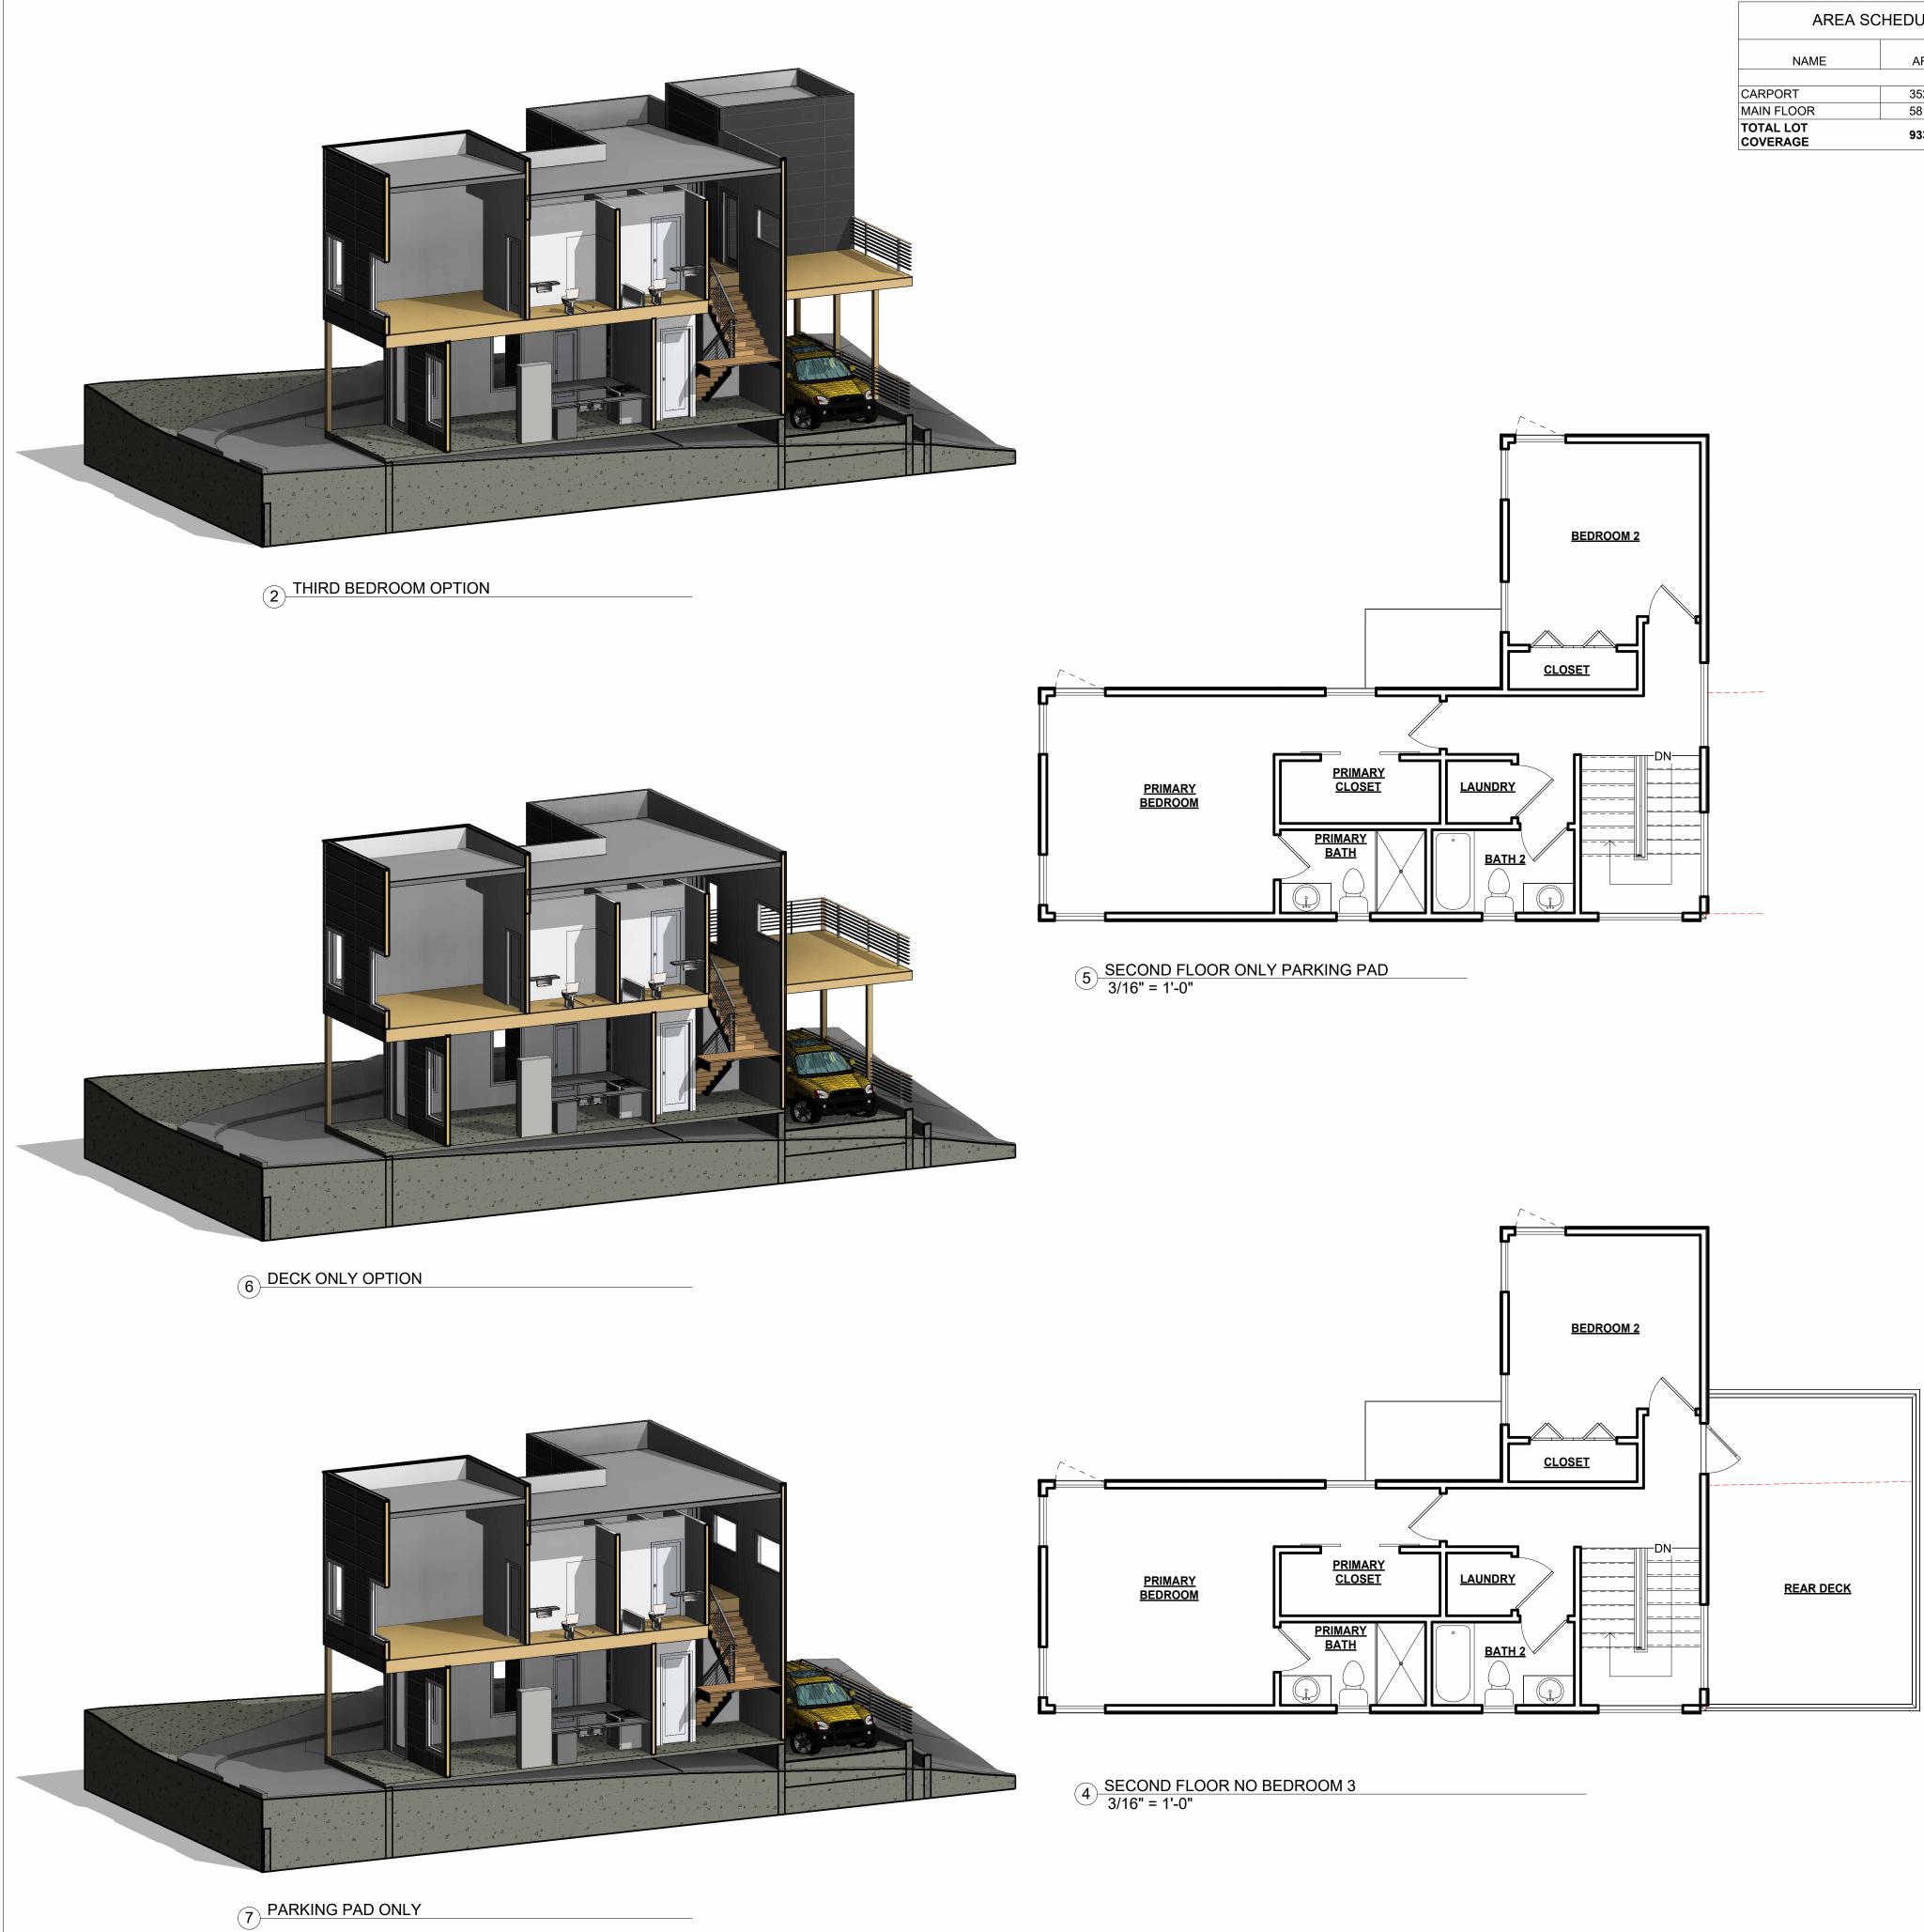


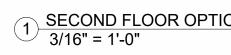

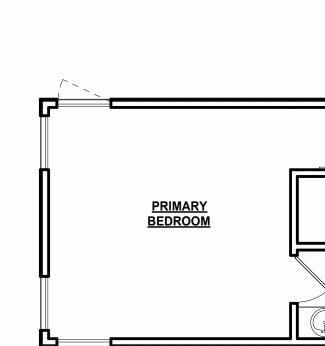


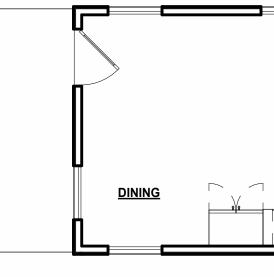

3 MAIN FLOOR 3/16" = 1'-0"

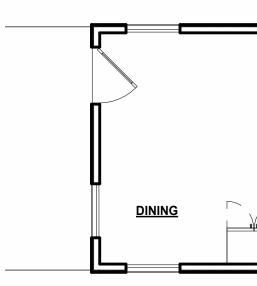



AREA SCHEDULE F.A.R AREA Site Area F.A.R Above/Below Grade L 581 SF 1809 SF 32% ABOVE GRADE DR 870 SF 1809 SF 48%	AREA SCHEDULE NAME CARPORT UNCOVERED DECK HEATED TOTAL MAIN FLOOR SECOND FLOOR TOTAL	AREA 352 SF 171 SF 523 SF 581 SF 870 SF 1451 SF 1974 SF	No. Description Date	RELEASED FOR CONSTRUCTION	
HALF BATH	10-0		DRAWN BY : CHRISTOPHER J MALONE DESIGNED BY: CHRIS MALONE DESIGNS	1/17/2024 3:08:14 PM	
			CONTRACTOR CONTACT: CHRIS MALONE DESIGNS LLC		DDUCED WITHOUT PERMISSION
BEDROOM 2	ET BEDROOM 3		OWNER CONTACT: DEREK BIGHAM NEW CONSTRUCTION		NS LLC AND SHALL NOT BE REPRO
TION 1	Le contra de la co		PLAN NAME PROJECT NUMBER : 2021-002 PROJECT ADDRESS:	AIS MALONE GA 30030 DESIGNS	THIS WORK IS THE INTELLECTUAL PROPERTY OF CJM DESIGNS LLC AND SHALL NOT BE REPRODUCI
			FLOOR PLANS	A1.1 CHRIS - DES	© COPYRIGHT - 2017

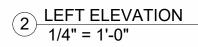




4 RIGHT ELEVATION 1/4" = 1'-0"

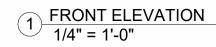

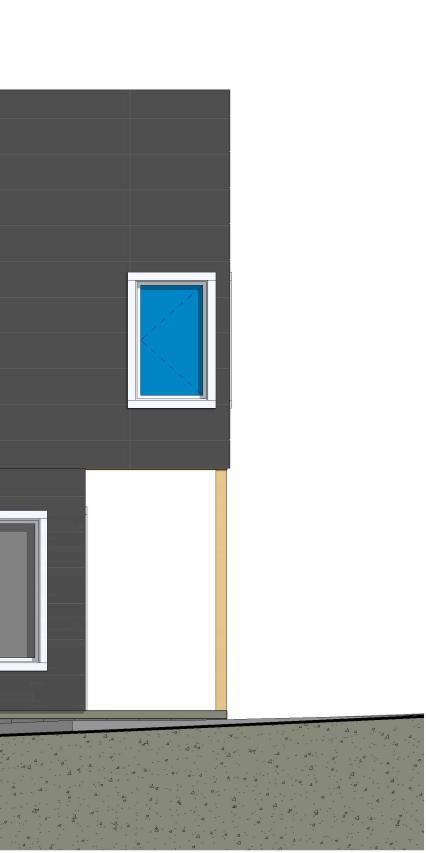


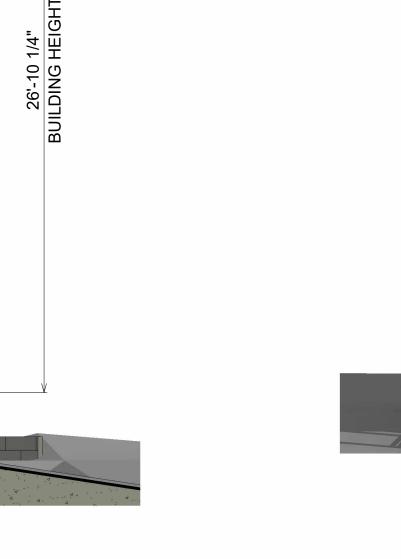



3 REAR ELEVATION 1/4" = 1'-0"

EVATIONS - W/ 3RD W/ 3RD W/ 3RD
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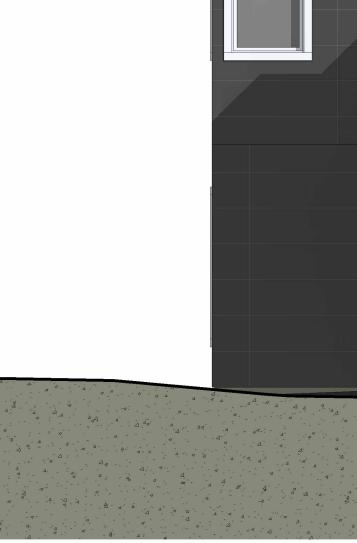


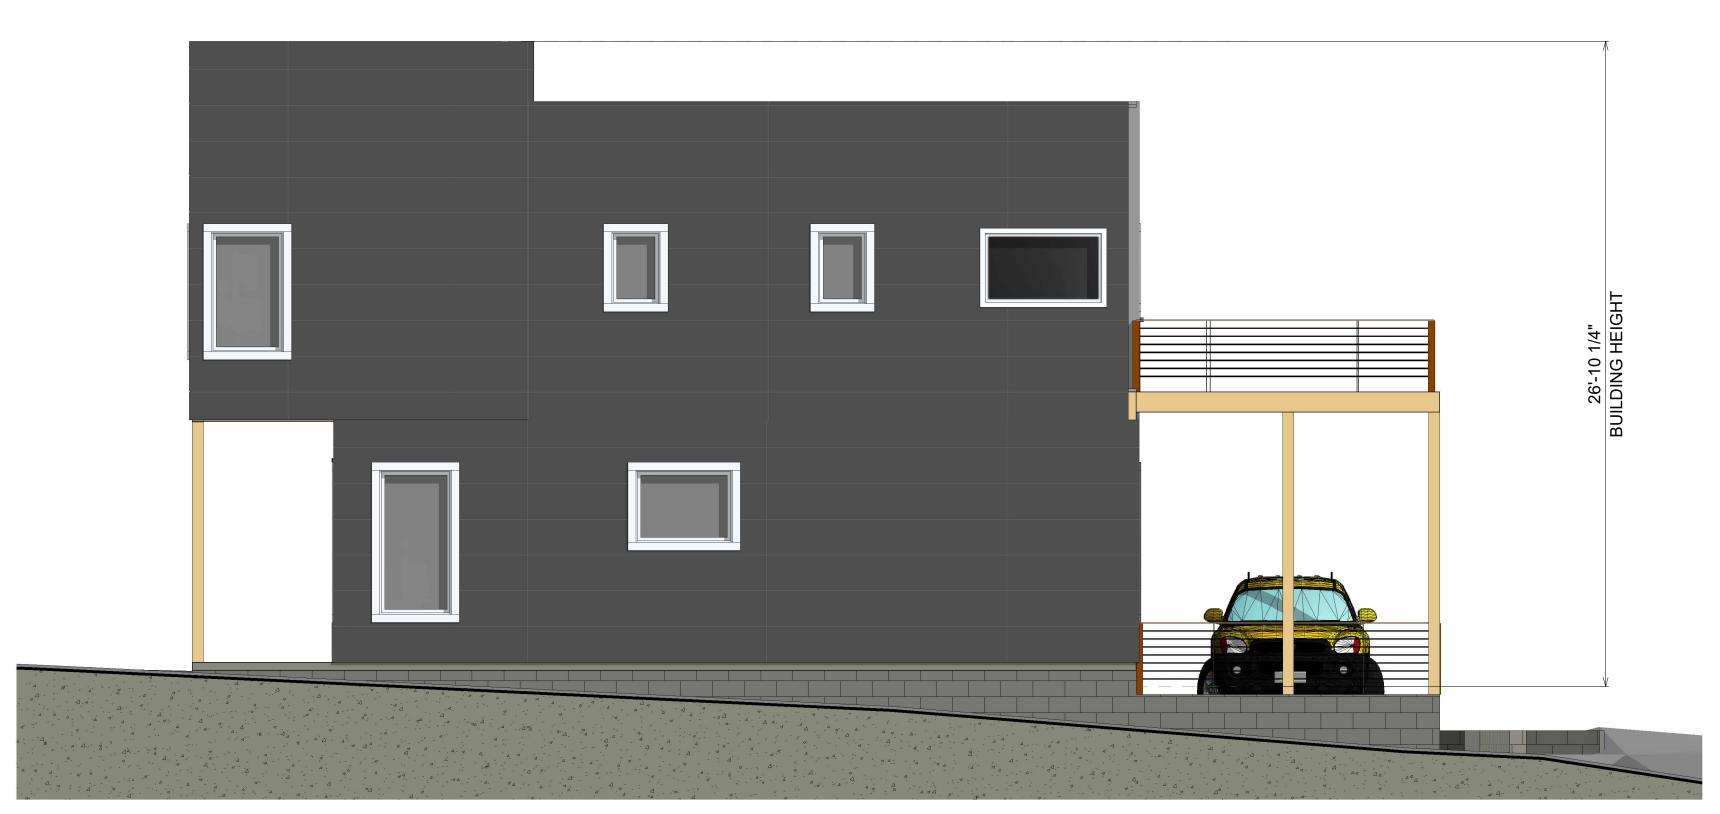4 RIGHT ELEVATION 1/4" = 1'-0"




2 LEFT ELEVATION 1/4" = 1'-0"


1 FRONT ELEVATION 1/4" = 1'-0"




3 REAR ELEVATION 1/4" = 1'-0"

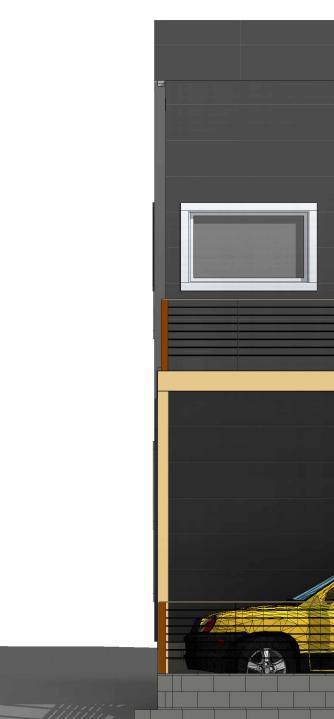

DNE No. Description SIGNS Date		RELEASED FOR CONSTRUCTION	
DRAWN BY : CHRISTOPHER J MALONE DESIGNED BY: CHRIS MALONE DESIGNS		1/17/2024 3:08:40 PM	
CONTRACTOR CONTACT: CHRIS MALONE	DESIGNS LLC		EPRODUCED WITHOUT PERMISSION
021-002 DEREK BIGHAM	R NEW CONSTRUCTION		CJM DESIGNS LLC AND SHALL NOT BE F
PLAN NAME PROJECT NUMBER : 2021-002		- DESIGNS - DESIGNS	THIS WORK IS THE INTELLECTUAL PROPERTY OF CJM DESIGNS LLC AND SHALL NOT BE REPRODUCED
ELEVATIONS -		N L	© COPYRIGHT - 2017

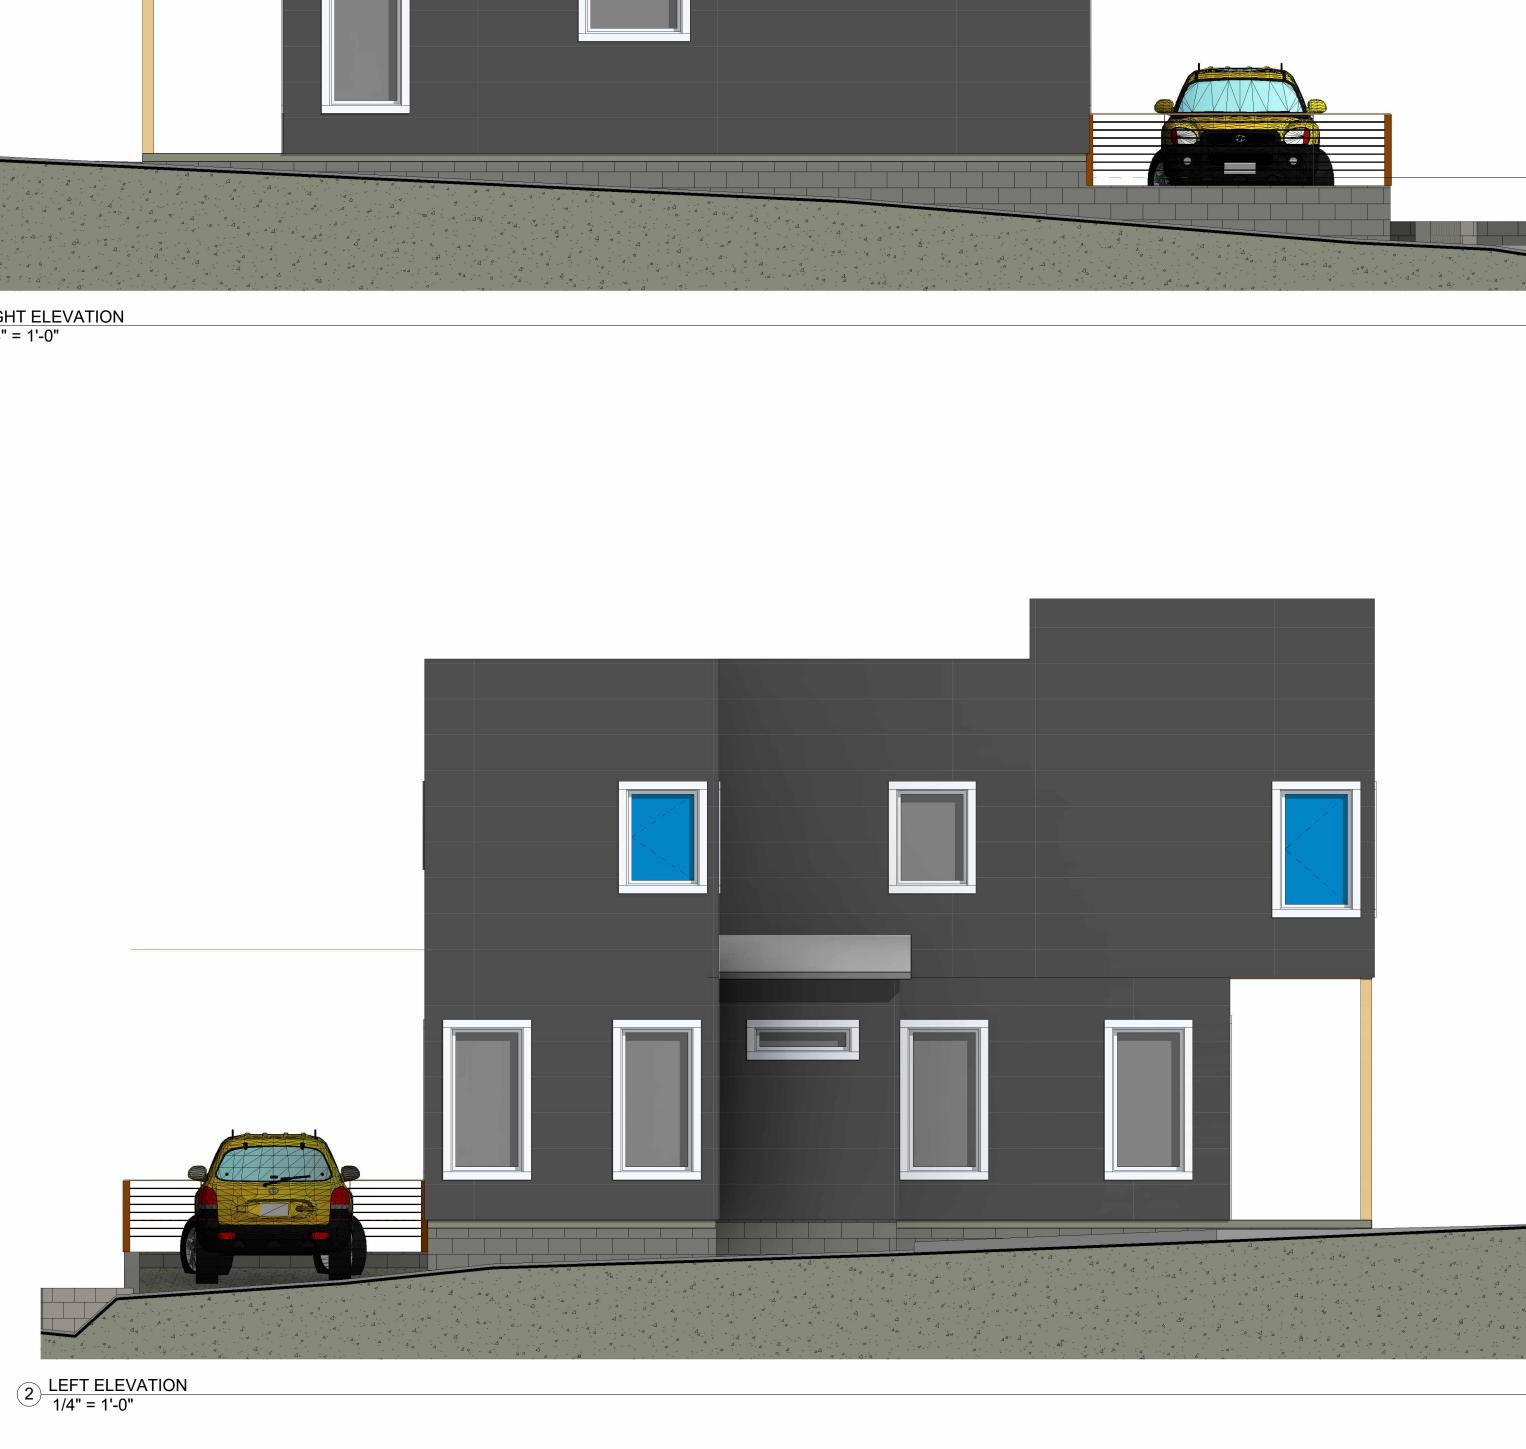


(4) RIGHT ELEVATION 1/4" = 1'-0"

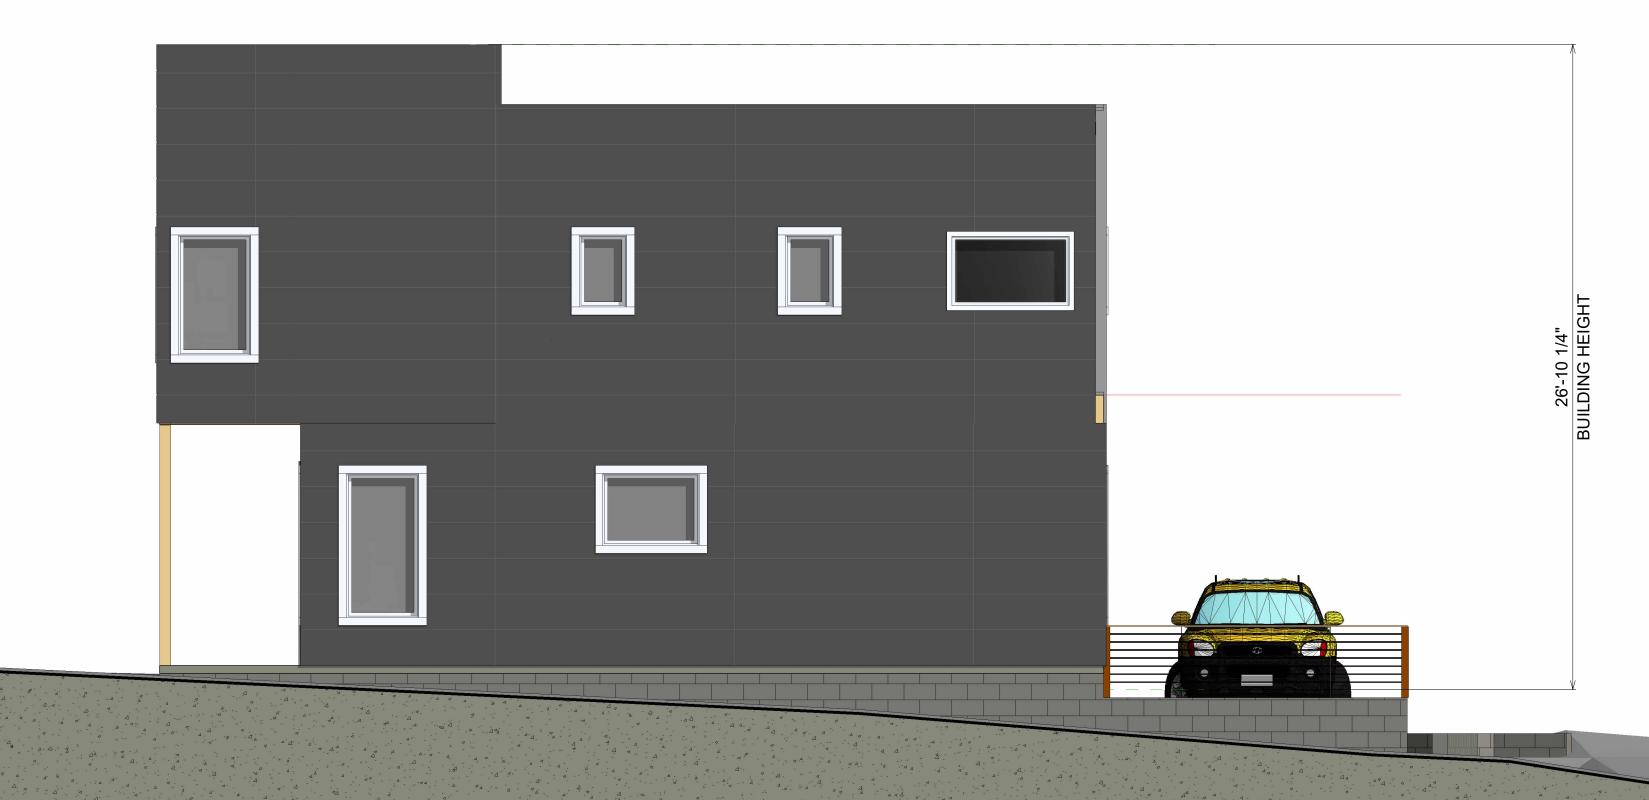



3 REAR ELEVATION 1/4" = 1'-0"

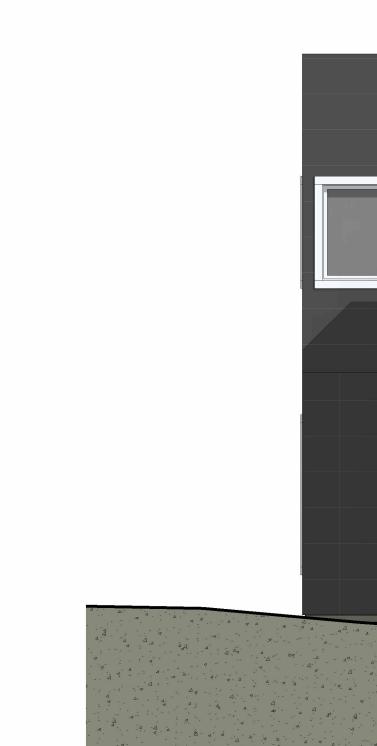

1 FRONT ELEVATION 1/4" = 1'-0"

ONS- IONS- IN DRAW BY: CHRISTOPHEJ MALONE DRAW BY: CHRISTOPHEJ MALONE IN MARE IN DRAW BF: 2021-002 OWNER CONTACT: DEREK BIGHAM OWNER CONTACT: DEREK BIGHAM DRAW BY: CHRISTOPHEJ MALONE IN MARE IN DESIGNED BY: CHRIS MALONE DESIGNS DRAW BY: CHRISTOPHEJ MALONE Description Description IN MARE OWNER : 2021-002 DEREK BIGHAM DESIGNED BY: CHRIS MALONE DESIGNS Description IN MARE DESIGNED BY: CHRIS MALONE DESIGNS DESIGNED BY: CHRIS MALONE DESIGNS Description IN MARE DESIGNS LLC DESIGNS LLC DESIGNS LLC IN DESIGNS DESIGNS IN DESIGNS DESIGNS IN DESIGNS	- Owner contact: Contractor contact: DRAWN BY : CHRISTOPHER J MALONE PROJECT NUMBER : 2021-002 DEREK BIGHAM CHRIS MALONE DESIGNE DBY: CHRIS MALONE PROJECT NUMBER : 2021-002 DEREK BIGHAM CHRIS MALONE DESIGNE DBY: CHRIS MALONE PROJECT ADDRESS: DENORTRUCTION DESIGNS LLC DESIGNE DBY: CHRIS MALONE C H R IS MA LO NE PROJECT ADDRESS: New CONSTRUCTION DESIGNS LLC C H R IS MA LO NE DESIGNS LLC DESIGNS LLC DESIGNS LLC D E S I G N S - D E S I G N S DESIGNS LLC THS WORK IS THE INTELLECTUAL PROPERTY OF CJM DESIGNS LLC AND SHALL NOT BE REPRODUCED WITHOUT PERMISSION DRAWN BY: CHRISTOPHER J MALONE
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